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CUSTOMER:	DRAWING NO.
BYRD	2024-019
DRAWING NAME:	•
SCALE:	Sheet #
1/8" = 1'-0"	
DATE:	A1
NOV 18, 2024	• •

OWNER & BUILDER'S NOTE

THESE PLANS SHALL NOT BE USED FOR CONSTRUCTION UNTIL STAMPED AND SIGNED BY A QUALIFIED DESIGNER & THE LOCAL BUILDING DEPARTMENT. THE BUILDER IS EXPECTED TO FOLLOW THESE PLANS, APPLICABLE BUILDING CODES AND LOCAL ORDINANCES. HE SHALL VERIFY THAT SIT CONDITIONS ARE CONSISTENT WITH THESE PLANS BEFORE STARTING CONSTRUCTION. WHILE THESE PLANS ARE DRAWN TO SHOW THE PROPOSED WORK AS ACCURATELY AS POSSIBLE, SCHEMATIC DETAILS MAY BE USED IN SOME CASES FOR CLARITY. WORK NOT SPECIFICALLY DETAILED SHALL BE CONSTRUCTED TO THE SAME QUALITY AS SIMILAR WORK THAT IS DETAILED.

WRITTEN DIMENSIONS AND SPECIFIC NOTES SHALL TAKE PRECEDENCE OVER SCALED DIMENSIONS AND GENERAL NOTES. THE DESIGNER SHALL BE CONSULTED FOR CLARIFICATION IF SITE CONDITIONS ARE ENCOUNTERED THAT ARE DIFFERENT THAN SHOWN, IF DISCREPANCIES ARE FOUND IN THE PLANS OR NOTES, OR IF A QUESTION ARISES OVER THE INTENT OF THE PLANS OR NOTES.

THE DESIGNER ASSUMES NO RESPONSIBILITY FOR SCHEDULING, FABRICATION, CONSTRUCTION TECHNIQUES OR MATERIALS, OR QUANTITIES USED IN THE WORK. THE DESIGNER ASSUMES NO RESPONSIBILITY FOR FIELD CHANGES, SITE VARIANCES OR DISCREPANCIES NOT BROUGHT TO HIS/HER ATTENTION FOR CLARIFICATION

THE INFORMATION SHOWN ON THIS

SITE PLAN WAS PROVIDED BY THE

OWNER, FIELD SURVEY OR

VERIFICATION WAS NOT MADE

OWNER:

PROJECT ADDRESS:

JURISDICTION

ZONING:

APN: SITE AREA:

PERMIT #:

SOIL PARAMETERS

BASED ON SOILS INDIGENOUS TO THE AREA:
BEARING PRESSURE - 1600 PSF
LATERAL ACTIVE PRESSURE 35 PSF
FLUID EQUIVALENT
SOIL-CONCRETE COEFFICIENT 0.35
SOIL PROFILE SD

EXTERIOR FINISH NOTES

EXTERIOR FINISH TO BE SIDING AND TYPAR OVER 1/16 OSB. MATERIAL AND COLOR BY

ROOFING TO BE LIGHT WEIGHT SHINGLES OVER 5/8" OSB W/ H CLIPS

CHIMNEY HEIGHT SHALL BE DETERMINED USING A 10' RADIUS PLANE AND SHALL BE 2' HIGHER THAN ANY ROOF SURFACE 10' FROM THE CHIMNEY.

DOWNSPOUTS TO BE COLLECTED AND ROOF RUN OFF TO BE DIRECTED AWAY FROM STRUCTURE.

FINISH GRADE SHALL SLOPE AWAY FROM STRUCTURE MIN. 1/2" PER FOOT OF RUN FOR

WINDOWS AND GLAZING

MINDOMS SHALL BE DOUBLE PANE MITH VINYL FRAMES AND CONFORM TO CANICSA-A440 MANUFACTURER AND COLOR TO BE DETERMINED BY OMNER.

EVERY BEDROOM SHALL BE PROVIDED WITH AN EGRESS WINDOW WITH FINISH SILL HEIGHT NOT GREATER THAN 39" ABOVE THE FINISH FLOOR HEIGHT (EXCLUDING BASEMENTS) AND SHALL HAVE A MINIMUM OPENABLE AREA OF 3.8 SQ. FT. EGRESS WINDOWS SHALL NOT HAVE AN OPENABLE AREA LESS THAN 15" WIDE OR 24" HIGH.

SAFETY GLAZING SHALL BE PROVIDED IN DOORS AND ENCLOSURES FOR HOT TUBS, WHIRLPOOLS, SAUNAS, STEAM ROOMS, BATHTUBS, AND SHOWERS.

ALL EXTERIOR DOORS AND WINDOWS SHALL BE FINISHED WITH WEATHER RESISTANT COATINGS AND WEATHER STRIPPED.

GENERAL NOTES

ALL WORK SHALL BE DONE IN ACCORDANCE WITH 2012 ONTARIO BUILDING CODE AND LOCAL CODES.

FOUNDATION AND TRUSS DESIGN SHALL BE VERIFIED BY A QUALIFIED ENGINEER FOR COMPLIANCE WITH SITE REQUIREMENTS.

DIMENSIONS AND NOTES SHALL TAKE PRECEDENCE OVER THE SCALING OF DRAWINGS.

WALL DIMENSIONS ARE TO THE EXTERIOR OF FRAMING UNLESS NOTED OTHERWISE.

LUMBER COMING IN CONTACT WITH CONCRETE OR MASONRY SHALL BE TREATED OR PROTECTED WITH AN APPROVED VAPOR BARRIER.

CONTINUOUS CONTACT WITH THE GROUND SHALL BE TREATED TO A MINIMUM OF .60 CCA.

ALL FRAMING LUMBER TO BE #2 OR BETTER DF OR EQUIVALENT, UNLESS NOTED OTHERWISE

EXTERIOR AND INTERIOR MATERIALS AND FINISHES TO BE DETERMINED BY OWNER.

ALL REQUIRED SMOKE ALARMS NEED A VISUAL COMPONENT.

BLOCKING FOR NON-LOAD BEARING INTERIOR WALLS PARALLEL TO FLOOR JOISTS SHALL BE MIN. 2x4 @ 4'-0" O.C

BUILDING PERFORMANCE

HEAT LOSS CALCULATIONS SHALL COMPLY WITH THE REQUIREMENTS OF REGIONAL AND LOCAL CODES. SEE CALCULATIONS.

PORCHES AND GARAGE AREAS NOT INCLUDED IN LIVING AREA

ALL EXHAUST FANS TO BE VENTED DIRECTLY TO THE EXTERIOR.

ALL PENETRATIONS OF THE BUILDING ENVELOPE SHALL BE SEALED WITH POLYURETHANE FOAM.

ALL COMBUSTION APPLIANCES WILL BE VENTED DIRECTLY TO THE EXTERIOR

FURNACE FIREBOX SHALL HAVE OUTSIDE COMBUSTION AIR SUPPLY PURSUANT TO REGIONAL AND LOCAL CODES.

ATTIC ACCESS SHALL BE:

A MINIMUM OF 22" X 36". THERE SHALL BE 30" MIN. CLEARANCE AT OR ABOVE THE OPENING.

LOCATED IN A CORRIDOR, HALLWAY OR OTHER READILY ACCESSIBLE LOCATION. ATTICS WITH A MAXIMUM VERTICAL HEIGHT OF LESS THAN 30" WILL NOT REQUIRE ACCESS OPENINGS

HATCHWAYS TO ATTIC OR ROOF SPACES SHALL BE FITTED WITH DOORS OR COVERS

YENTILATION:

WHERE INSULATION IS INSTALLED BETWEEN A CEILING AND THE UNDERSIDE OF THE ROOF SHEATHING, A SPACE SHALL BE PROVIDED BETWEEN THE INSULATION AND THE SHEATHING, AND VENTS SHALL BE INSTALLED TO PERMIT THE MOVEMENT OF AIR FROM THE SPACE TO THE EXTERIOR.

ATTIC SHALL HAVE VENTILATION EQUAL TO 1 SQ. FOOT PER 150 SQ. FEET OF ATTIC SPACE. VENTILATION SHALL BE PROTECTED FROM SNOW AND RAIN. OPENINGS SHALL BE LOCATED TO PROVIDE CROSS VENTILATION.

UNDER FLOOR SPACES SHALL HAVE VENTILATION EQUAL TO ONE SQ. FOOT PER 150 SQ. FEET OF FLOOR SPACE. VENTS SHALL BE CAST INTO THE CONCRETE STEM WALLS AND COVERED WITH GALVANIZED WIRE SCREEN, VENTS SHALL BE LOCATED TO PROVIDE CROSS VENTILATION.

RAILING NOTES:

STAIRWAYS SHALL HAVE A MIN. WIDTH OF 35" MEASURED BETWEEN WALL FACES OR GUARDS.

TREADS SHALL HAVE A MIN. TREAD OF 11" AND MIN. RUN OF 10". STAIR TREADS MUST BE UNIFORM AND CAN NOT VARY FROM THE LARGEST TO THE SMALLEST BY MORE THAN 1/4".

STAIRWAYS SHALL HAVE MIN. 6'-5" OF HEADROOM AT THE NOSE OF THE STAIR.

STAIRWAYS SHALL HAVE AT LEAST ONE HANDRAIL LOCATED 34" TO 38" ABOVE THE NOSING OF TREADS AND LANDINGS. THE HAND GRIP PORTION OF HANDRAILS SHALL NOT BE LESS THAN 1-1/2" OR GREATER THAN 2" IN CROSS-SECTIONAL DIMENSION.

HANDRAILS SHALL BE CONTINUOUS THE FULL LENGTH OF THE STAIRS. THE ENDS OF HANDRAILS SHALL RETURN TO WALL OR TERMINATE INTO A NEWEL POST OR SAFETY TERMINAL.

STAIRWAYS HAVING LESS THAN 2 RISERS DO NOT REQUIRE A HAND RAIL.

36" MIN. HEIGHT GUARDRAILS SHALL BE PROVIDED FOR AT PORCHES, DECKS, BALCONIES, STAIRWAYS AND LANDINGS WHERE THE ADJACENT SURFACE IS MORE THAN 24" BELOW.

RAILING AND GUARDRAIL BALUSTER SPACING SHALL BE NO GREATER THAN 4".

THE TRIANGULAR OPENINGS FORMED BY THE RISER, TREAD, AND BOTTOM OF GUARDRAIL SHALL NOT ALLOW A 4" DIAMETER SPHERE TO PASS THROUGH.

MIN. 77" HEADROOM HEIGHT OVER LANDINGS AS PER O.B.C. 9.8.6.4.(1)

DOORS

DOORS BETWEEN GARAGE AND LIVING AREA SHALL BE 1-3/4" TIGHT FITTING SOLID CORE DOORS WITH A RATING OF 20 MINUTES. DOOR SHALL BE SELF CLOSING.

MAIN ENTRANCE DOORS TO DWELLING UNITS SHALL BE PROVIDED WITH, A DOOR VIEWER OR TRANSPARENT GLAZING IN THE DOOR, OR A SIDELIGHT

INTERIOR DOORS TO BE PRE-PRIMED MDF. STYLE AND FINISH BY OWNER.

GARAGE DOORS TO BE SECTIONAL, OVERHEAD DOORS, MATERIALS AND FINISH TO BE DETERMINED BY OWNER.

					DC	OOR SCHEDULE		
NUMBER	QTY	FLOOR	MIDTH	HEIGHT	R/0	DESCRIPTION	AREA, ACTUAL (SQ FT)	COMMENTS
D01	2	1	30"	80"	32 1/2"X83 1/2"	HINGED-3 PANEL	16.67	
D02	1	1	192"	96"	195"X98"	GARAGE-GARAGE DOOR PO3	128	
D03	1_1_	11	30"	54"	32 1/2"X57 1/2"	HINGED-3 PANEL	11.25	
D04	1	1	32"	80"	34 1/2"X83 1/2"	HINGED-3 PANEL	17.78	
D05	1'	1	74"	94 1/8"	75"X95 1/8"	MULLED UNIT-HL	48.37	
D06	1	1	36"	80"	38 1/2"X83 1/2"	DOUBLE HINGED-3 PANEL	20	
דסם	2	1	36"	80"	38 1/2"X83 1/2"	HINGED-3 PANEL	20	
D08	1	1	96"	95 1/2"	99"X99 1/4"	EXT. SLIDER-GLASS PANEL	63.67	
D09	1	2	26"	80"	28 1/2"X83 1/2"	HINGED-3 PANEL	14.44	
D10	1 '	2	28"	80"	30 1/2"X83 1/2"	HINGED-3 PANEL	15.56	
D11	2	2	30"	80"	32 1/2"X83 1/2"	HINGED-3 PANEL	16.67	
D12	1 '	2	36"	31 9/16"	38 1/2"X35 1/16"	HINGED-3 PANEL	7.9	
D13	3	2	36"	80"	38 1/2"X83 1/2"	HINGED-3 PANEL	20	
D14	4	2	40"	80"	42 1/2"X83 1/2"	DOUBLE HINGED-3 PANEL	22.22	
D15	1	2	96"	80"	99"X83 3/4"	EXT. SLIDER-GLASS PANEL	53.33	
TOTALS:		1		·	1		635.86	

	MINDOM SCHEDULE											
NUMBER	QTY	FL00R	SIZE	MIDTH	HEIGHT	R/0	DESCRIPTION	AREA, ACTUAL (SQ FT)	COMMENTS			
M01	1	2	4018	48"	20"	49"X21"	FIXED GLASS	6.67				
M02	2	1	8060	96"	72"	47"X73"	TRIPLE CASEMENT-LHL/RHR	48				
MOB	1	2	3030	36"	36"	37"X37"	SINGLE CASEMENT-HL	9				
M04	1	2	2850	32"	60"	33"X61"	SINGLE CASEMENT-HL	13.33				
M05	1	2	2850	32"	60"	33"X61"	SINGLE CASEMENT-HR	13.33				
M06	1	2	6050	72"	60"	73"×61"	DOUBLE CASEMENT-LHL	30				
MOT	1	2	6050	72"	60"	73"X61"	DOUBLE CASEMENT-RHR	30				
MOB	1	2	80311	96"	46 3/4"	97"X47 3/4"	TRIPLE CASEMENT-LHL/RHR	31.17				
M09	2	2	8050	96"	60"	97"X61"	TRIPLE CASEMENT-LHL/RHR	40				
TOTALS:								304.5				

NOTES: DOUBLE PANE WINDOWS / DOORS GRIDS AS PER ELEVATIONS

REVISIONS	DATE	
1. SITE PLAN UPDATED & MINDOMS CORRECTED	DEC 04	
2. UPDATED SITE PLAN	DEC 05	
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BYRD
2024-019

DRAWING NAME:
GENERAL NOTES

SCALE:
1/8" = 1'-0"

Sheet #

NOV 18, 2024



LIVING



STAIRS



KITCHEN/DINING

CUSTOMER:	DRAWING NO.
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47'-2 1/2" 23'-7 1/4" 23'-7 1/4" 13'-7 1/4" 14'-7 1/4" 2 1/2" (R10) STYRORAIL SRP-400 HI-DENSITY RIGID INSULATION UNDER FOOTINGS FOR FROST PROTECTION 2 1/2" (R10) SRP-200 HIDENSITY RIGID INSULATION UNDER CONC. SLABS DROP FOUNDATION FOR DOOR (8'-4" MIDE × 0'-8" HIGH) 45'-10 1/2" 14'-8 1/4" LINE OF FLAT SLAB UNEXCAVATED 4'-6 3/4' ਨ 3" CONCRETE SLAB AT 20 MPa (2910 PSI) AFTER 20 DAYS, 5 TO 3% AIR ENTRAINMENT. 6 MIL POLY VAPOUR BARRIER (LAPPED MIN. 12") 4" (R16) SRP-200 RIGID INSULATION 6" CRUSHED STONE 36" × 36" × 12" CONC. FTG PAD 4 - 15M REBAR BOTH WAYS 1 A10 19'-3 1/4" 26'-7 1/4" DROP FOUNDATION FOR DOOR (16'-4" WIDE × 0'-8" HIGH) 2 1/2" (R10) SRP-200 HI-DENSITY RIGID INSULATION UNDER CONC. SLABS 2 1/2" (R10) STYRORAIL SRP-400 HI-DENSITY RIGID INSULATION UNDER FOOTINGS FOR FROST PROTECTION 3'-6 1/4" 3'-6 1/4" 33'-11 3/4" 13'-2 3/4"

FOUNDATION PLAN

ALL OUTSIDE DIMENSIONS ARE FROM CONCRETE

4

8" CONC. FOUN. MALL

1

8" CONC. FOUN. WALL W/ 2 ½" STYROFOAM

CUSTOMER: BYRD **DRAWING NO.** 2024-019

DRAWING NAME:

FOUNDATION PLAN


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Sheet #

PATE: NOV 18, 2024

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GROUND FLOOR PLAN - 556 SQ.FT.

STUD WALL LEGEND

HALF-MALL

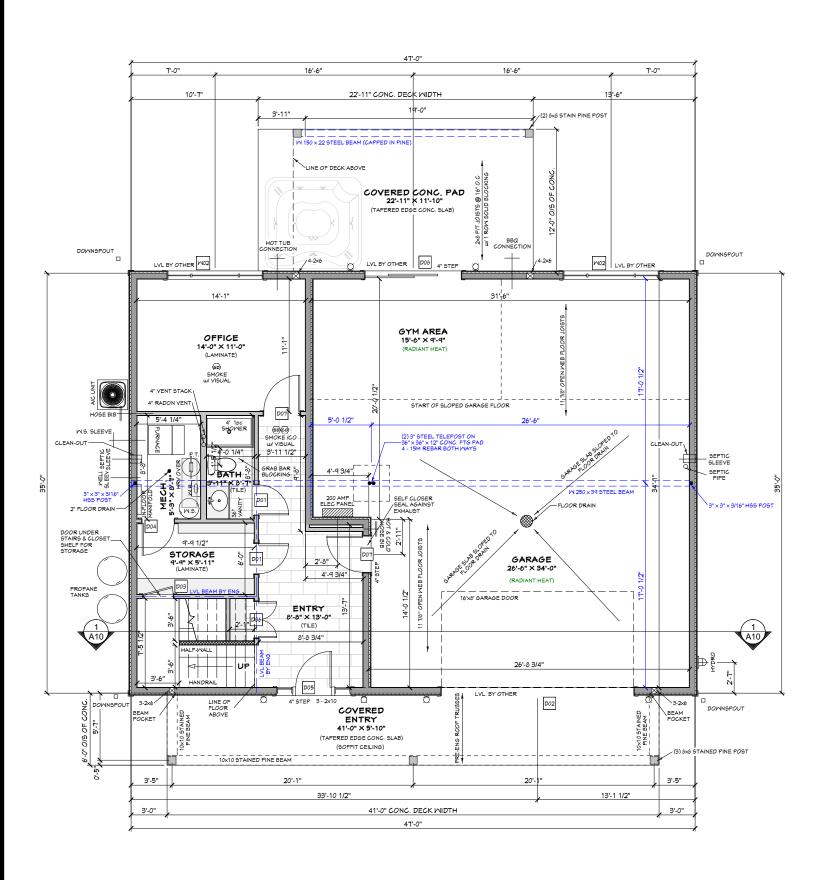ALL OUTSIDE DIMENSIONS ARE FROM FRAMING

ALL INTERIOR DIMENSIONS ARE FROM FRAMING

					DC	OR SCHEDULE		
NUMBER	QTY	FL00R	MIDTH	HEIGHT	R/0	DESCRIPTION	AREA, ACTUAL (SQ FT)	COMMENTS
D01	2	1	30"	80"	32 1/2"X83 1/2"	HINGED-3 PANEL	16.67	
D02	1	1	192"	96"	195"X98"	GARAGE-GARAGE DOOR P03	128	
D03	1	1	30"	54"	32 1/2"×57 1/2"	HINGED-3 PANEL	11.25	
D04	1	1	32"	80"	34 1/2"X83 1/2"	HINGED-3 PANEL	17.78	
D05	1	1	74"	94 1/8"	75"X95 1/8"	MULLED UNIT-HL	48.37	
D06	1	1	36"	80"	38 1/2"×83 1/2"	DOUBLE HINGED-3 PANEL	20	
דסם	2	1	36"	80"	38 1/2"X83 1/2"	HINGED-3 PANEL	20	
D08	1	1	96"	95 1/2"	99"X99 1/4"	EXT. SLIDER-GLASS PANEL	63.67	
D09	1	2	26"	80"	28 1/2"×83 1/2"	HINGED-3 PANEL	14.44	
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D12	1	2	36"	31 9/16"	38 1/2"X35 1/16"	HINGED-3 PANEL	7.9	
D13	3	2	36"	80"	38 1/2"×83 1/2"	HINGED-3 PANEL	20	
D14	4	2	40"	80"	42 1/2"X83 1/2"	DOUBLE HINGED-3 PANEL	22.22	
D15	1	2	96"	80"	99"X83 3/4"	EXT. SLIDER-GLASS PANEL	53.33	
TOTALS:							635.86	

	MINDOM SCHEDULE											
NUMBER	QTY	FL00R	SIZE	MIDTH	HEIGHT	R/0	DESCRIPTION	AREA, ACTUAL (SQ FT)	COMMENTS			
M01	1	2	4018	48"	20"	49"X21"	FIXED GLASS	6.67				
M02	2	1	8060	96"	72"	97"X73"	TRIPLE CASEMENT-LHL/RHR	48				
MOB	1	2	3030	36"	36"	37"X37"	SINGLE CASEMENT-HL	9				
M04	1	2	2850	32"	60"	33"×61"	SINGLE CASEMENT-HL	13.33				
M05	1	2	2850	32"	60"	33"X61"	SINGLE CASEMENT-HR	13.33				
M06	1	2	6050	72"	60"	73"X61"	DOUBLE CASEMENT-LHL	30				
MOT	1	2	6050	72"	60"	73"×61"	DOUBLE CASEMENT-RHR	30				
MOB	1	2	80311	96"	46 3/4"	97"X47 3/4"	TRIPLE CASEMENT-LHL/RHR	31,17				
MOA	2	2	8050	96"	60"	97"X61"	TRIPLE CASEMENT-LHL/RHR	40				
TOTALS:								309.5				

CUSTOMER: DRAWING NO. BYRD 2024-019 DRAWING NAME: GROUND FLOOR PLAN

Sheet #

SCALE :

1/8" = 1'-0"

DATE:


NOV 18, 2024

STUD WALL LEGEND

HALF-MALL

ALL OUTSIDE DIMENSIONS ARE FROM FRAMING

ALL INTERIOR
DIMENSIONS
ARE FROM FRAMING

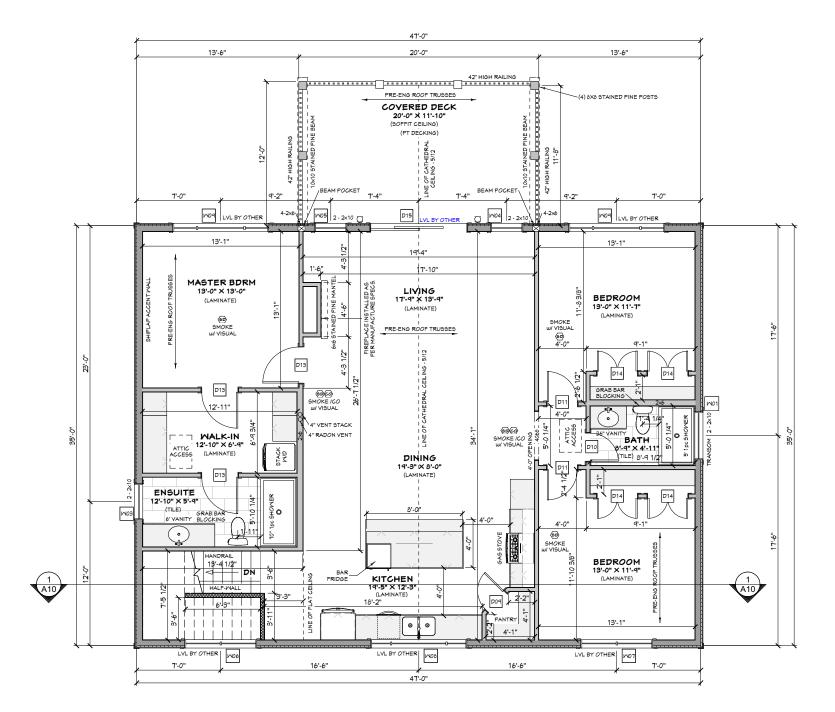

					DO	OR SCHEDULE		
NUMBER	QTY	FLOOR	MIDTH	HEIGHT	R/0	DESCRIPTION	AREA, ACTUAL (SQ FT)	COMMENTS
D01	2	1	30"	80"	32 1/2"X83 1/2"	HINGED-3 PANEL	16.67	
D02	1	1	192"	96"	195"X98"	GARAGE-GARAGE DOOR P03	128	
D03	1	1	30"	54"	32 1/2"X57 1/2"	HINGED-3 PANEL	11.25	
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D10	1	2	28"	80"	30 1/2"X83 1/2"	HINGED-3 PANEL	15.5 <i>6</i>	
D11	2	2	30"	80"	32 1/2"X83 1/2"	HINGED-3 PANEL	16.67	
D12	1	2	36"	31 9/16"	38 1/2"X35 1/16"	HINGED-3 PANEL	7.9	
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D14	4	2	40"	80"	42 1/2"X83 1/2"	DOUBLE HINGED-3 PANEL	22.22	
D15	1	2	96"	80"	99"X83 3/4"	EXT. SLIDER-GLASS PANEL	53.33	
TOTALS:							635.86	

	MINDOW SCHEDULE												
NUMBER	QTY	FL00R	SIZE	MIDTH	HEIGHT	R/0	DESCRIPTION	AREA, ACTUAL (SQ FT)	COMMENTS				
M01	1	2	4018	48"	20"	49"X21"	FIXED GLASS	6.67					
M02	2	1	8060	96"	72"	97"X73"	TRIPLE CASEMENT-LHL/RHR	48					
M03	1	2	3030	36"	36"	37"X37"	SINGLE CASEMENT-HL	9					
M04	1	2	2850	32"	60"	33"×61"	SINGLE CASEMENT-HL	13.33					
M05	1	2	2850	32"	60"	33"X61"	SINGLE CASEMENT-HR	13.33					
M06	1	2	6050	72"	60"	73"X61"	DOUBLE CASEMENT-LHL	30					
MOT	1	2	6050	72"	60"	73"X61"	DOUBLE CASEMENT-RHR	30					
MOB	1	2	80311	96"	46 3/4"	97"X47 3/4"	TRIPLE CASEMENT-LHL/RHR	31.17					
POM	2	2	8050	96"	60"	97"X61"	TRIPLE CASEMENT-LHL/RHR	40					
TOTALS:								309.5					


SECOND FLOOR PLAN - 1645 SQ.FT.


BYRD 2024-019

DRAWING NAME:
SECOND FLOOR PLAN

SCALE:
1/8" = 1'-0"

DATE:
NOV 18, 2024

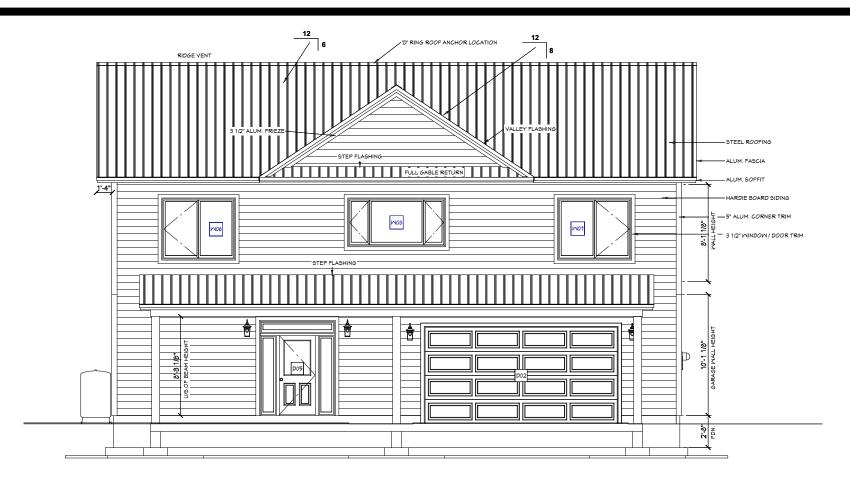

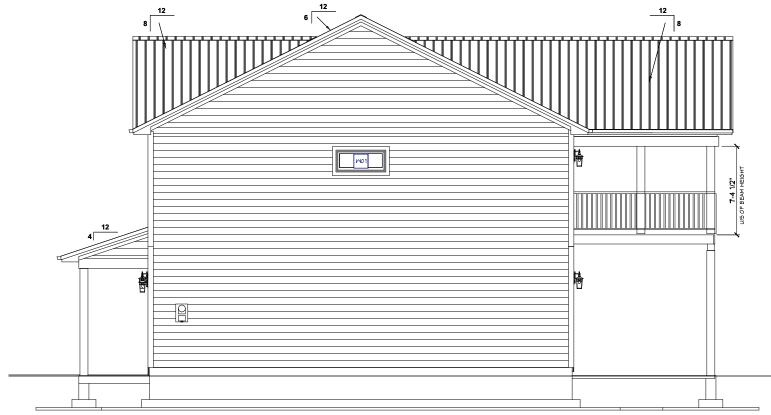

RIGHT ELEVATION


FRONT ELEVATION

CUSTOMER:
BYRD
2024-019


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ELEVATIONS

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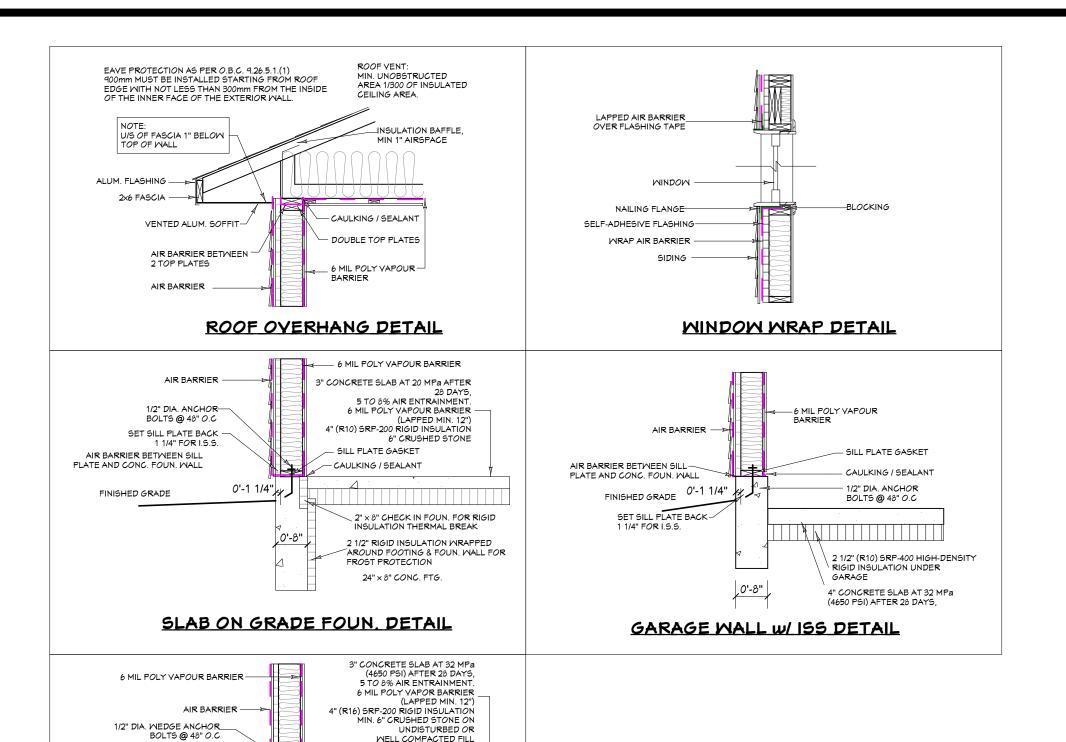
LEFT ELEVATION

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UNDISTURBED OR WELL COMPACTED FILL

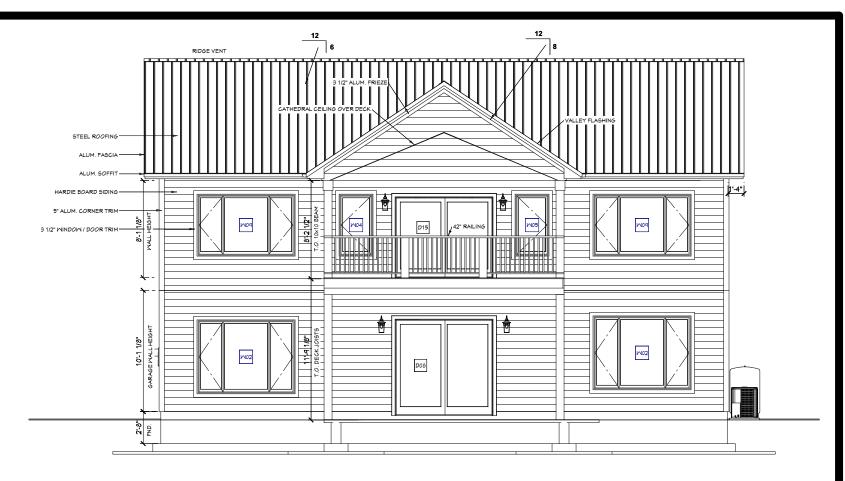SILL PLATE GASKET

24" × 8" CONC. FTG.

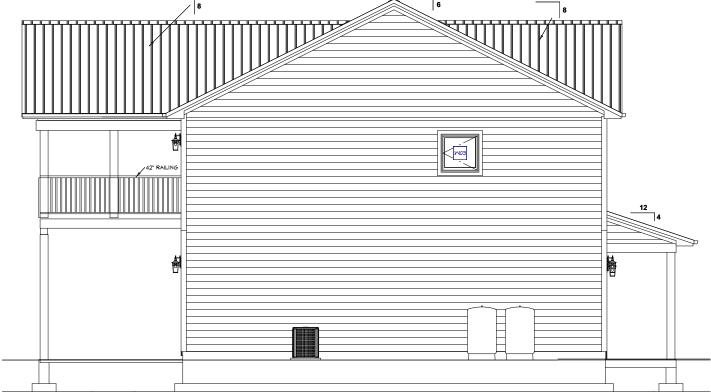CAULKING / SEALANT

FOUN. DETAIL AT SIDING

,0'-8"

AIR BARRIER BETWEEN SILL

2 1/2" (R10) STYRORAL SRP-

INSULATION UNDER FOOTINGS FOR FROST PROTECTION

4'-0"

PLATE AND CONC. FOUN. WALL SET SILL PLATES BACK 1 1/4" FROM EDGE OF ICF

