

OWNER & BUILDER'S NOTE

THESE PLANS SHALL NOT BE USED FOR CONSTRUCTION UNTIL STAMPED AND SIGNED BY A QUALIFIED DESIGNER & THE LOCAL BUILDING DEPARTMENT. THE BUILDER IS EXPECTED TO FOLLOW THESE PLANS, APPLICABLE BUILDING CODES AND LOCAL ORDINANCES. HE SHALL VERIFY THAT SIT CONDITIONS ARE CONSISTENT WITH THESE PLANS BEFORE STARTING CONSTRUCTION. WHILE THESE PLANS ARE DRAWN TO SHOW THE PROPOSED WORK AS ACCURATELY AS POSSIBLE, SCHEMATIC DETAILS MAY BE USED IN SOME CASES FOR CLARITY. WORK NOT SPECIFICALLY DETAILED SHALL BE CONSTRUCTED TO THE SAME QUALITY AS SIMILAR WORK THAT IS DETAILED.

WRITTEN DIMENSIONS AND SPECIFIC NOTES SHALL TAKE PRECEDENCE OVER SCALED DIMENSIONS AND GENERAL NOTES. THE DESIGNER SHALL BE CONSULTED FOR CLARIFICATION IF SITE CONDITIONS ARE ENCOUNTERED THAT ARE DIFFERENT THAN SHOWN, IF DISCREPANCIES ARE FOUND IN THE PLANS OR NOTES, OR IF A QUESTION ARISES OVER THE INTENT OF THE PLANS

THE DESIGNER ASSUMES NO RESPONSIBILITY FOR SCHEDULING, FABRICATION, CONSTRUCTION TECHNIQUES OR MATERIALS, OR QUANTITIES USED IN THE WORK. THE DESIGNER ASSUMES NO RESPONSIBILITY FOR FIELD CHANGES, SITE VARIANCES OR DISCREPANCIES NOT BROUGHT TO HIS/HER ATTENTION FOR CLARIFICATION

THE INFORMATION SHOWN ON THIS

SITE PLAN WAS PROVIDED BY THE

OWNER, FIELD SURVEY OR

VERIFICATION WAS NOT MADE

OWNER

PROJECT ADDRESS:

JURISDICTION ZONING

SITE AREA PERMIT #

SOIL PARAMETERS:

BEARING PRESSURE - 1600 PSF LATERAL ACTIVE PRESSURE 35 PSF FLUID EQUIVALENT SOIL-CONCRETE COEFFICIENT 0.35 SOIL PROFILE SD

BASED ON SOILS INDIGENOUS TO THE

EXTERIOR FINISH NOTES

EXTERIOR FINISH TO BE SIDING AND TYPAR OVER 7/16 OSB. MATERIAL AND COLOR BY

ROOFING TO BE LIGHT WEIGHT SHINGLES OVER 5/8" OSB W H CLIPS

CHIMNEY HEIGHT SHALL BE DETERMINED USING A 10' RADIUS PLANE AND SHALL BE 2' THAN ANY ROOF SURFACE 10' FROM THE CHIMNEY.

DOWNSPOUTS TO BE COLLECTED AND ROOF RUN OFF TO BE DIRECTED AWAY FROM

FINISH GRADE SHALL SLOPE AWAY FROM STRUCTURE MIN. 1/2" PER FOOT OF RUN FOR

WINDOWS AND GLAZING

NINDOWS SHALL BE DOUBLE PANE WITH VINYL FRAMES AND CONFORM TO CAN/CSA-A440 MANUFACTURER AND COLOR TO BE DETERMINED BY OWNER.

EVERY BEDROOM SHALL BE PROVIDED WITH AN EGRESS WINDOW WITH FINISH SILL HEIGHT NOT GREATER THAN 39" ABOYE THE FINISH FLOOR HEIGHT (EXCLUDING BASEMENTS) AND SHALL HAVE A MINIMUM OPENABLE AREA OF 3.8 SQ. FT. EGRESS WINDOWS SHALL NOT HAVE AN OPENABLE AREA LESS THAN 15" WIDE OR 24" HIGH.

SAFETY GLAZING SHALL BE PROVIDED IN DOORS AND ENCLOSURES FOR HOT TUBS. NHIRLPOOLS, SAUNAS, STEAM ROOMS, BATHTUBS, AND SHOWERS

ALL EXTERIOR DOORS AND WINDOWS SHALL BE FINISHED WITH WEATHER RESISTANT

GENERAL NOTES

ALL WORK SHALL BE DONE IN ACCORDANCE WITH 2012 ONTARIO BUILDING CODE AND LOCAL CODES.

FOUNDATION AND TRUSS DESIGN SHALL BE VERIFIED BY A QUALIFIED ENGINEER FOR COMPLIANCE

DIMENSIONS AND NOTES SHALL TAKE PRECEDENCE OVER THE SCALING OF DRAWINGS.

WALL DIMENSIONS ARE TO THE EXTERIOR OF FRAMING UNLESS NOTED OTHERWISE.

LUMBER COMING IN CONTACT WITH CONCRETE OR MASONRY SHALL BE TREATED OR PROTECTED WITH AN APPROVED VAPOR BARRIER

CONTINUOUS CONTACT WITH THE GROUND SHALL BE TREATED TO A MINIMUM OF .60 CCA.

ALL FRAMING LUMBER TO BE #2 OR BETTER DF OR EQUIVALENT, UNLESS NOTED OTHERWISE

EXTERIOR AND INTERIOR MATERIALS AND FINISHES TO BE DETERMINED BY OWNER

ALL REQUIRED SMOKE ALARMS NEED A VISUAL COMPONENT

BLOCKING FOR NON-LOAD BEARING INTERIOR WALLS PARALLEL TO FLOOR JOISTS SHALL BE MIN. 2x4 @ 4'-0" O.C

BUILDING PERFORMANCE

HEAT LOSS CALCULATIONS SHALL COMPLY WITH THE REQUIREMENTS OF REGIONAL AND LOCAL CODES. SEE CALCULATIONS.

PORCHES AND GARAGE AREAS NOT INCLUDED IN LIVING AREA

ALL EXHAUST FANS TO BE VENTED DIRECTLY TO THE EXTERIOR

ALL PENETRATIONS OF THE BUILDING ENVELOPE SHALL BE SEALED WITH POLYURETHANE FOAM.

ALL COMBUSTION APPLIANCES WILL BE VENTED DIRECTLY TO THE EXTERIOR.

FURNACE FIREBOX SHALL HAVE OUTSIDE COMBUSTION AIR SUPPLY PURSUANT TO REGIONAL AND

ATTIC ACCESS SHALL BE:

A MINIMUM OF 22" X 36". THERE SHALL BE 30" MIN. CLEARANCE AT OR ABOVE THE OPENING.

LOCATED IN A CORRIDOR, HALLWAY OR OTHER READILY ACCESSIBLE LOCATION. ATTICS WITH A MAXIMUM VERTICAL HEIGHT OF LESS THAN 30" WILL NOT REQUIRE ACCESS OPENINGS

HATCHWAYS TO ATTIC OR ROOF SPACES SHALL BE FITTED WITH DOORS OR COVERS

YENTILATION:

WHERE INSULATION IS INSTALLED BETWEEN A CEILING AND THE UNDERSIDE OF THE ROOF SHEATHING, A SPACE SHALL BE PROVIDED BETWEEN THE INSULATION AND THE SHEATHING, AND VENTS SHALL BE INSTALLED TO PERMIT THE MOVEMENT OF AIR FROM THE SPACE TO THE EXTERIOR.

ATTIC SHALL HAVE VENTILATION EQUAL TO 1 SQ. FOOT PER 150 SQ. FEET OF ATTIC SPACE. VENTILATION SHALL BE PROTECTED FROM SNOW AND RAIN. OPENINGS SHALL BE LOCATED TO PROVIDE CROSS VENTILATION.

UNDER FLOOR SPACES SHALL HAVE VENTILATION EQUAL TO ONE SQ. FOOT PER 150 SQ. FEET OF FLOOR SPACE. VENTS SHALL BE CAST INTO THE CONCRETE STEM WALLS AND COVERED WITH GALVANIZED WIRE SCREEN, VENTS SHALL BE LOCATED TO PROVIDE CROSS VENTILATION

RAILING NOTES:

STAIRWAYS SHALL HAVE A MIN. WIDTH OF 35" MEASURED BETWEEN WALL FACES OR GUARDS.

TREADS SHALL HAVE A MIN. TREAD OF 11" AND MIN. RUN OF 10". STAIR TREADS MUST BE UNIFORM AND FROM THE LARGEST TO THE SMALLEST BY MORE THAN 1/4".

STAIRWAYS SHALL HAVE MIN. 6'-5" OF HEADROOM AT THE NOSE OF THE STAIR

STAIRWAYS SHALL HAVE AT LEAST ONE HANDRAIL LOCATED 34" TO 38" ABOVE THE NOSING OF TREADS AND LANDINGS. THE HAND GRIP PORTION OF HANDRAILS SHALL NOT BE LESS THAN 1-1/2" OR GREATER THAN 2" IN CROSS-SECTIONAL DIMENSION

HANDRAILS SHALL BE CONTINUOUS THE FULL LENGTH OF THE STAIRS. THE ENDS OF HANDRAILS SHALL RETURN TO WALL OR TERMINATE INTO A NEWEL POST OR SAFETY TERMINAL

STAIRWAYS HAVING LESS THAN 2 RISERS DO NOT REQUIRE A HAND RAIL

36" MIN. HEIGHT GUARDRAILS SHALL BE PROVIDED FOR AT PORCHES, DECKS, BALCONIES, STAIRWAYS AND LANDINGS WHERE THE ADJACENT SURFACE IS MORE THAN 24" BELOW.

RAILING AND GUARDRAIL BALUSTER SPACING SHALL BE NO GREATER THAN 4"

THE TRIANGULAR OPENINGS FORMED BY THE RISER, TREAD, AND BOTTOM OF GUARDRAIL SHALL NOT ALLOW A 4" DIAMETER SPHERE TO PASS THROUGH.

MIN. 77" HEADROOM HEIGHT OVER LANDINGS AS PER O.B.C. 9.8.6.4.(1)

DOORS

DOORS BETWEEN GARAGE AND LIVING AREA SHALL BE 1-3/4" TIGHT FITTING SOLID CORE DOORS WITH A RATING OF 20 MINUTES. DOOR SHALL BE SELF CLOSING

MAIN ENTRANCE DOORS TO DWELLING UNITS SHALL BE PROVIDED WITH, A DOOR VIEWER OR TRANSPARENT GLAZING IN THE DOOR, OR A SIDELIGHT

INTERIOR DOORS TO BE PRE-PRIMED MDF. STYLE AND FINISH BY OWNER.

GARAGE DOORS TO BE SECTIONAL, OVERHEAD DOORS, MATERIALS AND FINISH TO BE DETERMINED BY

					MIN	NDOW SC	HEDULE	
NUMBER	QTY	FLOOR	SIZE	MIDTH	HEIGHT	R/0	DESCRIPTION	AREA, ACTUAL (SQ FT)
M01	2	1	4036	48"	42"	49"X43"	DOUBLE CASEMENT-LHL	14
M02	2	1	4036	48"	42"	49"X43"	DOUBLE CASEMENT-RHR	14
TOTALS:								56

					DOOR SCH	IEDULE	
NUMBER	QTY	FLOOR	MIDTH	HEIGHT	R/0	DESCRIPTION	AREA, ACTUAL (SQ FT)
D01	1	1	24"	80"	26 1/2"X83 1/2"	HINGED-3 PANEL	13.33
D02	1	1	26"	80"	53 1/4"X84 1/2"	POCKET-3 PANEL	14.44
D03	2	1	32"	80"	34 1/2"X83 1/2"	HINGED-3 PANEL	17.78
D04	3	1	34"	80"	36 1/2"X83 1/2"	HINGED-3 PANEL	18.89
D05	1	1	36"	80"	39"X83 3/4"	EXT. HINGED-DOOR E20	20
DOT	1	1	48"	80"	50 1/2"X84 1/2"	SLIDER-DOOR P05	26.67
TOTALS:							166.67

NOTES: DOUBLE PANE WINDOWS / DOORS GRIDS AS PER ELEVATIONS

REVISIONS

KLYISIONS	DAIL		
1. JOB MEETING REVISIONS	OCT 11/24	Lockwood l	Brothers
2. SEPTIC PLAN / PERMIT READY	OCT 31/24	CONSTRUC	
3. SURVEY INFO ADDED	NOV 12/24	The undersigned has reviewed and tak design, and has the qualifications and m	eets the requirements set
4. BUILDING MOVED AHEAD	NOV 22/24	out in the Ontario Buildi Qualification Informa	11 12. A. C.
5. NEW SEPTIC DESIGN	NOV 27/24	JOHN SPYK John L	12/2 47179
6. UPDATED SEPTIC & BUILDING LOCATION	DEC 13/24	NAME SIGNATURE	. (
7. RELOCATED SEPTIC TO REAR LOT	FEB 04/25	FIRM CUSTOMER:	DRAWING NO.
8.		MCNICKLE	2024-016
٩.		DRAWING NAME:	
10.	8	GENERAL N	NOTES
		SCALE: 3/16" = 1'-0"	Sheet #
		DATE: OCT 10, 2024	A2

DATE

LIVING





KITCHEN

Lockwood Brothers CONSTRUCTION

The undersigned has reviewed and takes responsibility for this design, and has the qualifications and meets the requirements so out in the Ontario Building Code.

JOHN SPYK

Jahr Shife SIGNATURE

ATURE /

OOD BROTHERS CONSTRUCTION

DRAWING NO.

CUSTOMER: MCNICKLE

2024-016

DRAWING NAME:

SCALE :


3/16" = 1'-0"


Sheet #

DATE:

OCT 10, 2024

A3

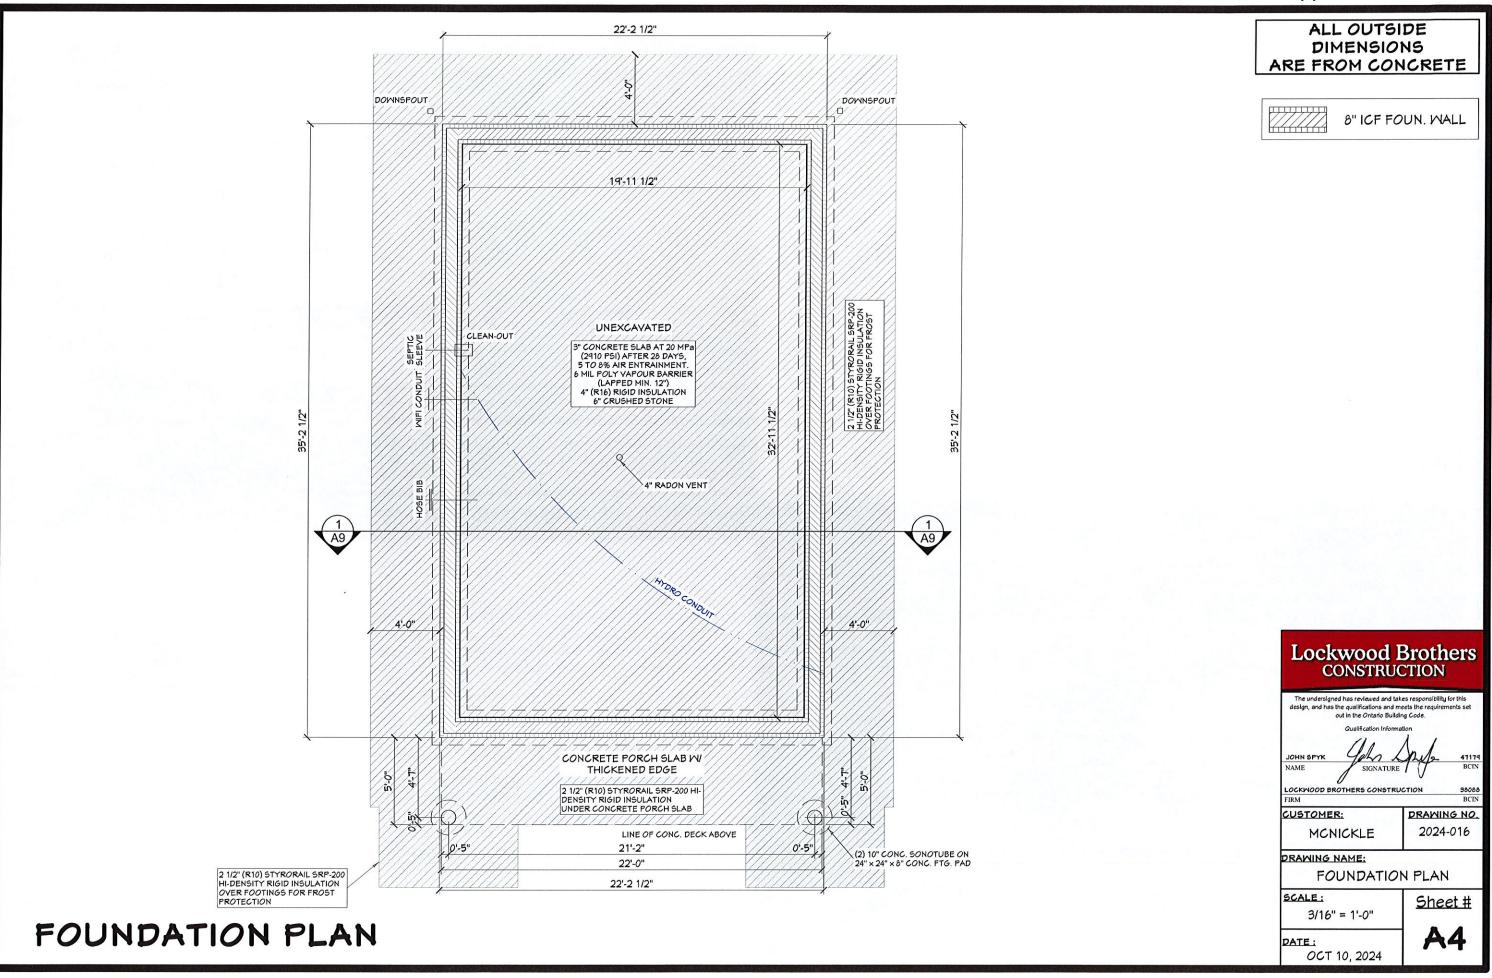

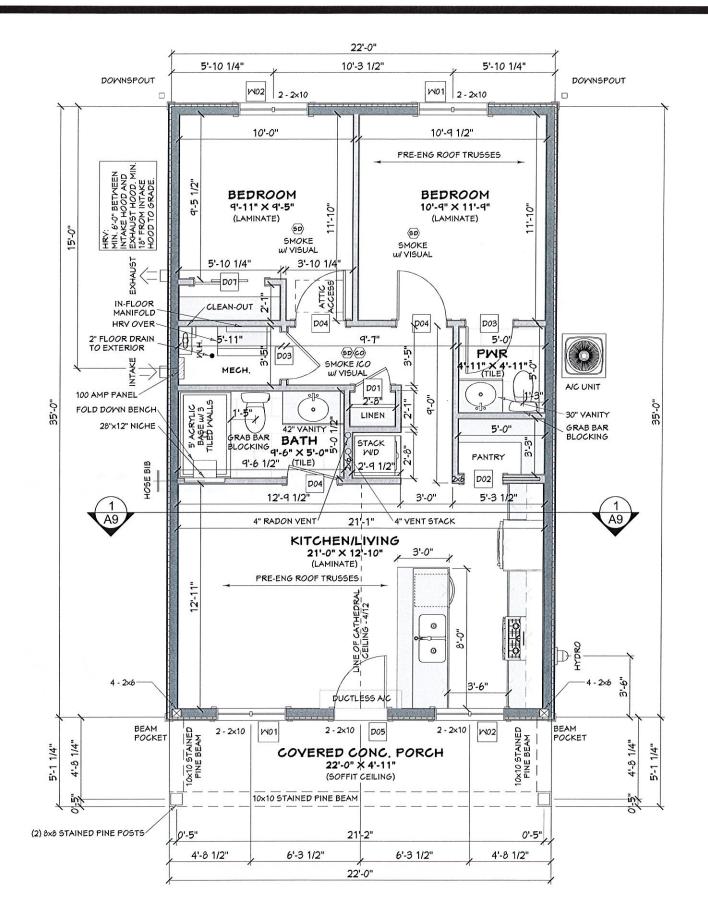

GROUND FLOOR PLAN - 770 SQ.FT.


ALL OUTSIDE DIMENSIONS ARE FROM FRAMING


ALL INTERIOR
DIMENSIONS
ARE FROM FRAMING


					MII	ndow sc	HEDULE	
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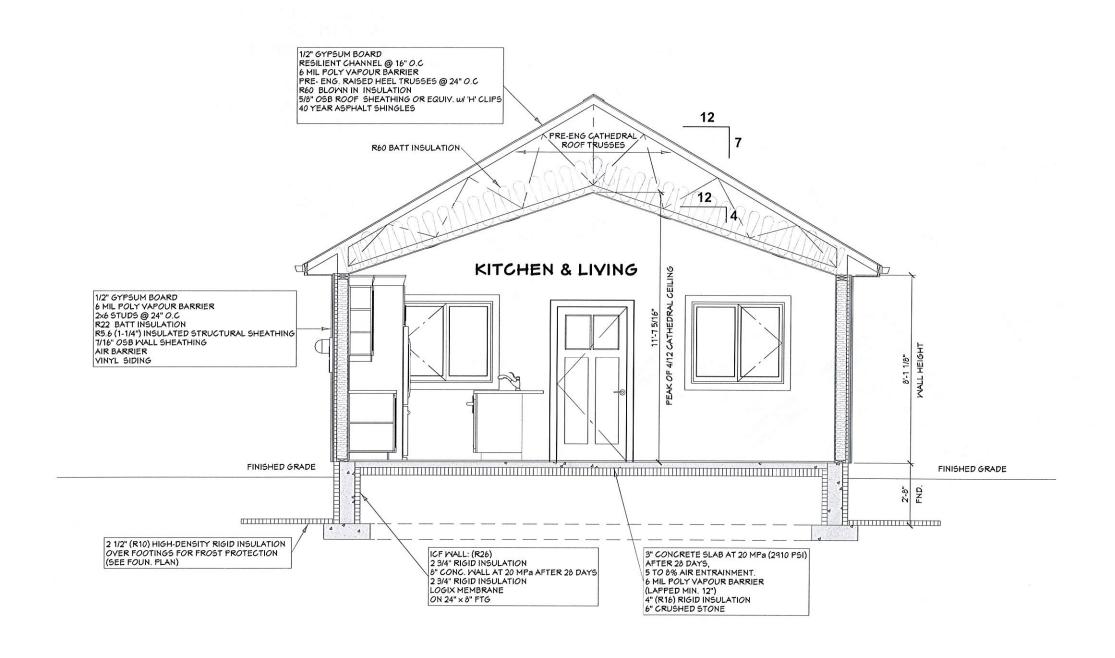






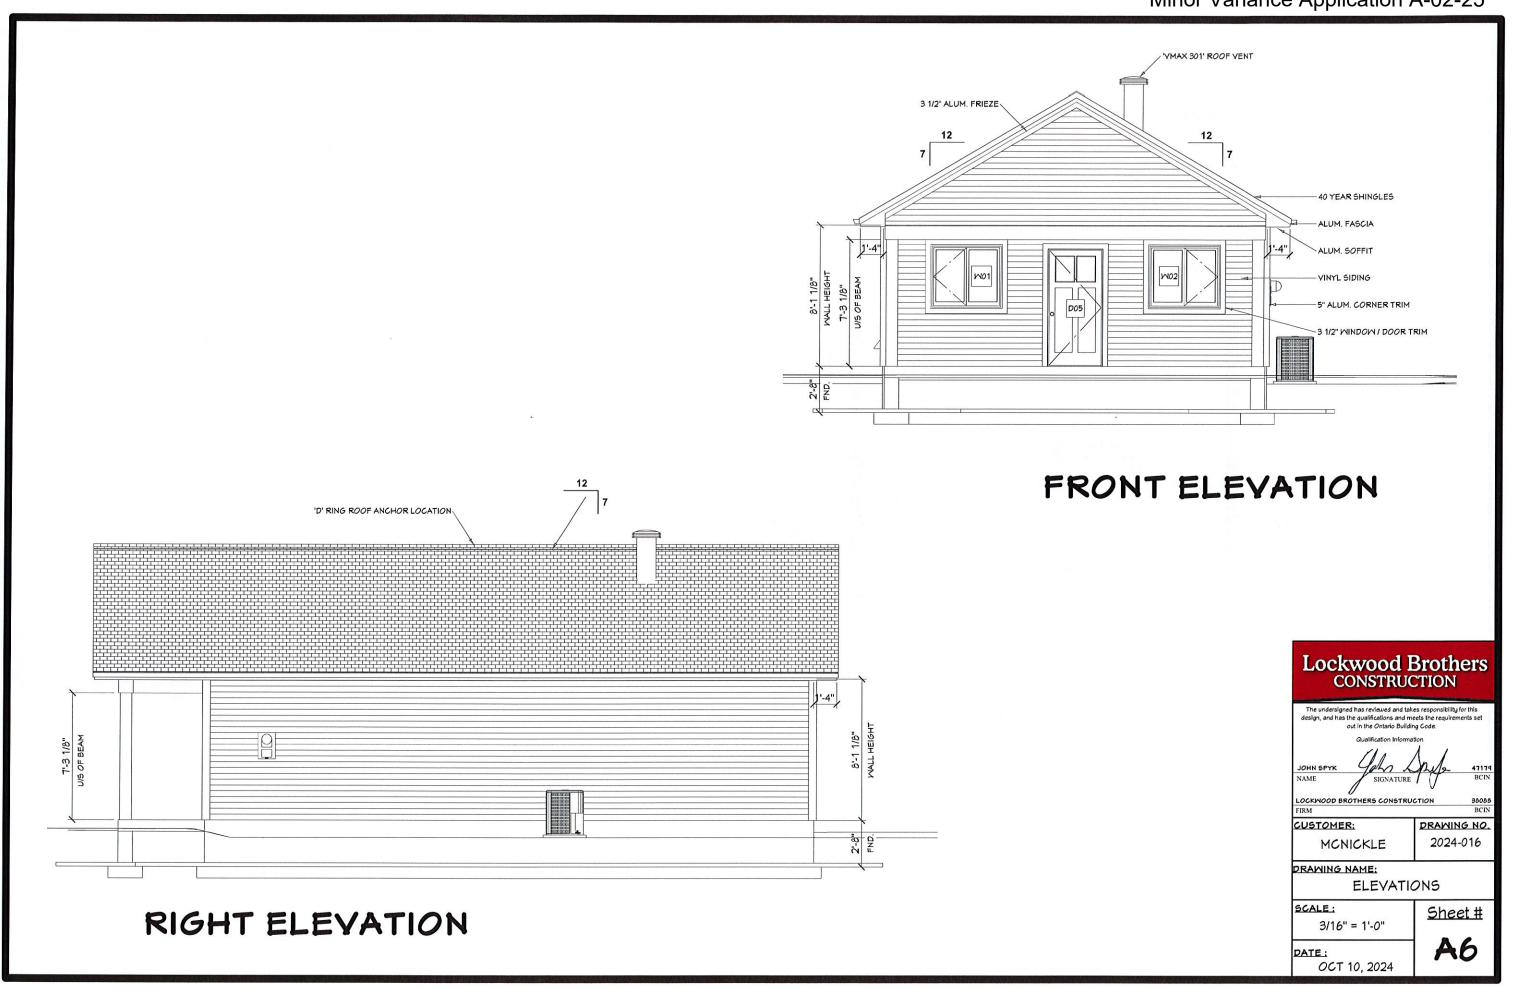

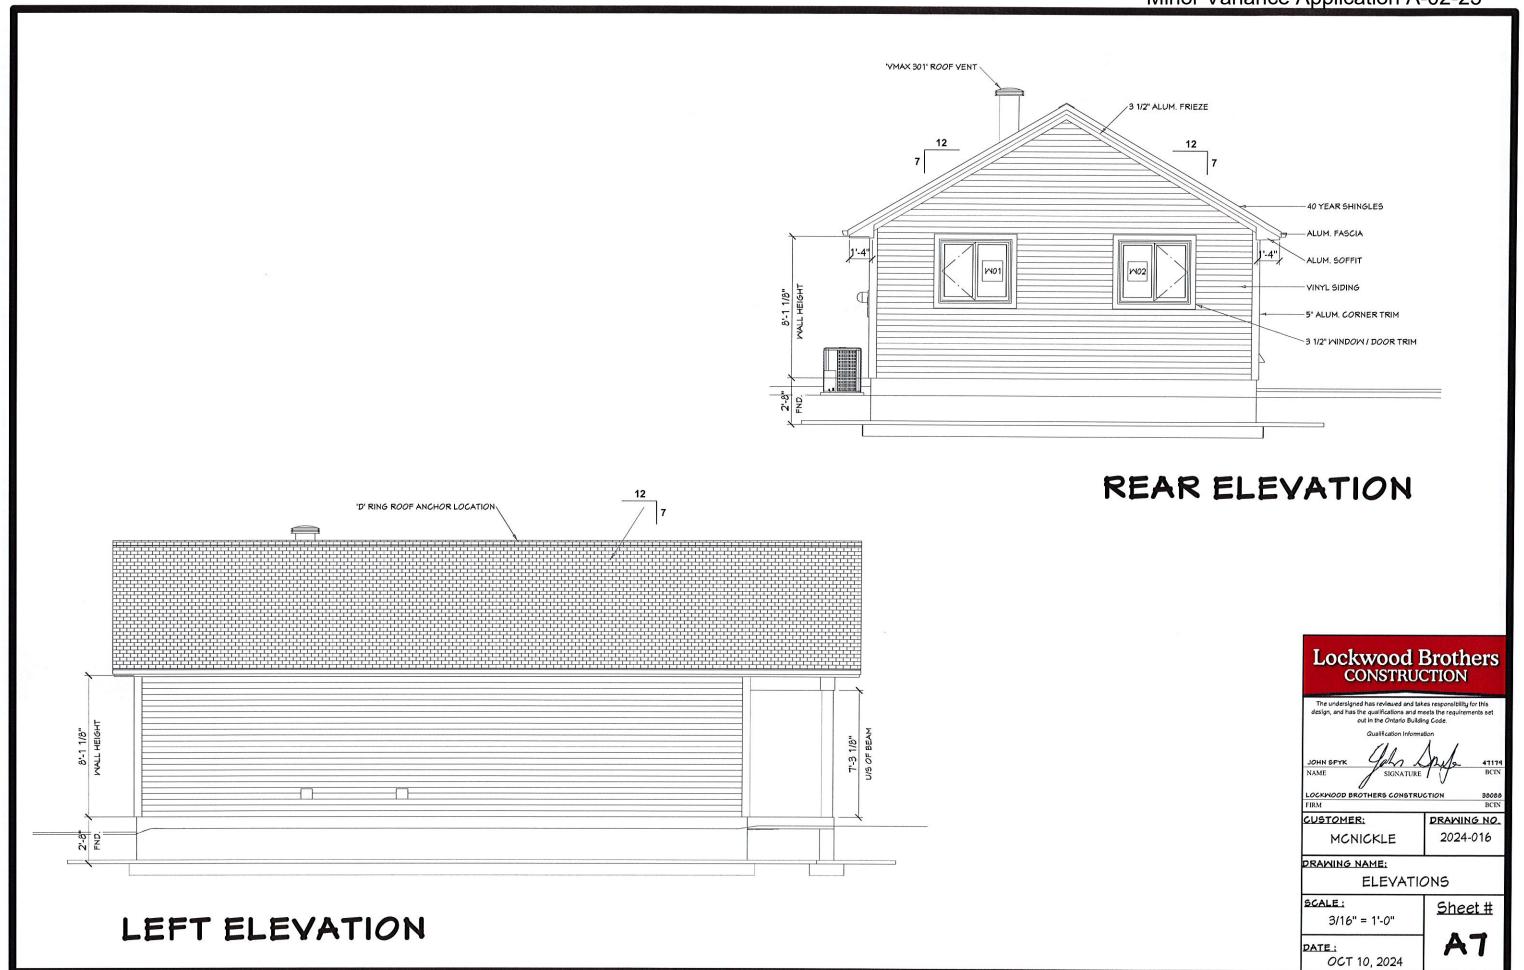

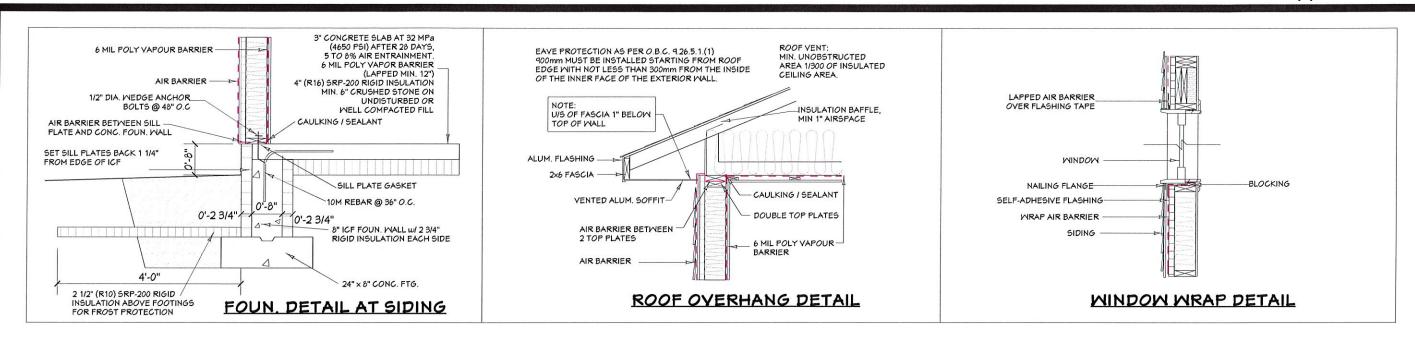

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BUILDING SECTION

SCALE: 1/4" = 1'-0"



The undersigned has reviewed and takes responsibility for this design, and has the qualifications and meets the requirements set out in the Ontario Building Code.

JOHN SPYK NAME

IAME

HERS CONSTRUCTION

LOCKWOOD BROTHERS CONSTRUCTION

MCNICKLE

CUSTOMER: DRAWING NO.

DRAWING NAME:

BUILDING SECTION

SCALE:

Sheet #

A9

2024-016

BCIN

DATE:

OCT 10, 2024